

1 GROUND FLOOR PLUMBING PLAN
 P-1 P-2 SCALE 1:150

2 SECOND FLOOR PLUMBING PLAN
 P-3 P-4 SCALE 1:150

3 THIRD FLOOR PLUMBING PLAN
 P-1 P-1 SCALE 1:150



PREPARED BY: ROMBLON STATE UNIVERSITY OFFICE OF PHYSICAL PLANT AND FACILITIES		MASTER NUMBER:		CHECKED BY:		PROJECT TITLE:		SHEET CONTENT:	
JERRY SUNGAL PRC DESIGNER (Signature)		LASON P. RUFON APPROVED BY: (Signature)		REHABILITATION AND FINISHING OF OLD/EXISTING UNIVERSITY BUILDING		SS SHOWN		PREPARED BY:	
								CAD OPERATOR:	
								BCSC / STM JOB NO.:	
PTR No.: Date:		SHEET NO.:		LOCATION: ROMBLON STATE UNIVERSITY - Main Campus, Linao, Guevara, Romblon		P-1			
TIN:		(Blank)							

PLUMBING NOTES :

1. ALL SANITARY WORKS INCLUDED HEREIN SHALL BE EXECUTED ACCORDING TO THE PROVISIONS OF THE NATIONAL PLUMBING CODE OF THE PHILIPPINES, NATIONAL BUILDING CODE OF THE PHILIPPINES AND ITS IMPLEMENTING AND REGULATIONS.
2. COORDINATE THE DRAWING WITH THE OTHER RELATED DRAWINGS AND SPECIFICATIONS. THE ARCHITECT AND/OR THE ENGINEER SHALL BE NOTIFIED IMMEDIATELY OF ANY DISCREPANCY FOUND THEREIN HIS/HER DECISION SHALL BE FINAL.
3. ALL PIPES SHALL BE INSTALLED AS INDICATED ANY RELOCATION REQUIRED FOR PROPER EXECUTION OF OTHER TRADES SHALL BE WITH PRIOR APPROVAL OF THE ARCHITECT/ENGINEER.
4. PROPOSED SANITARY UTILITIES SHALL CONFORM TO THE ACTUAL LOCATION, DEPTH AND INVERTED ELEVATION OF EXISTING PIPES AND STRUCTURES AS VERIFIED BY THE CONTRACTORS.
5. THE CONTRACTORS SHALL BE RESPONSIBLE FOR ALL REQUIRED FLOOR AND WALL OPENINGS.
6. ALL SLOPE FOR HORIZONTAL DRAINAGE SHALL MAINTAIN 1% MINIMUM UNLESS OTHERWISE NOTED.
7. SIZE OF WATER SUPPLY PIPES TO FIXTURES SHALL BE IN ACCORDANCE WITH THE MANUFACTURER'S INSTRUCTIONS.




LEGEND:

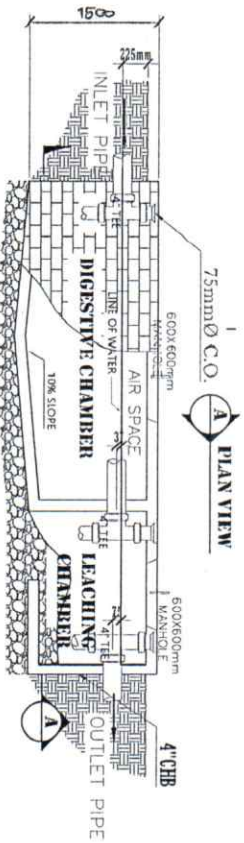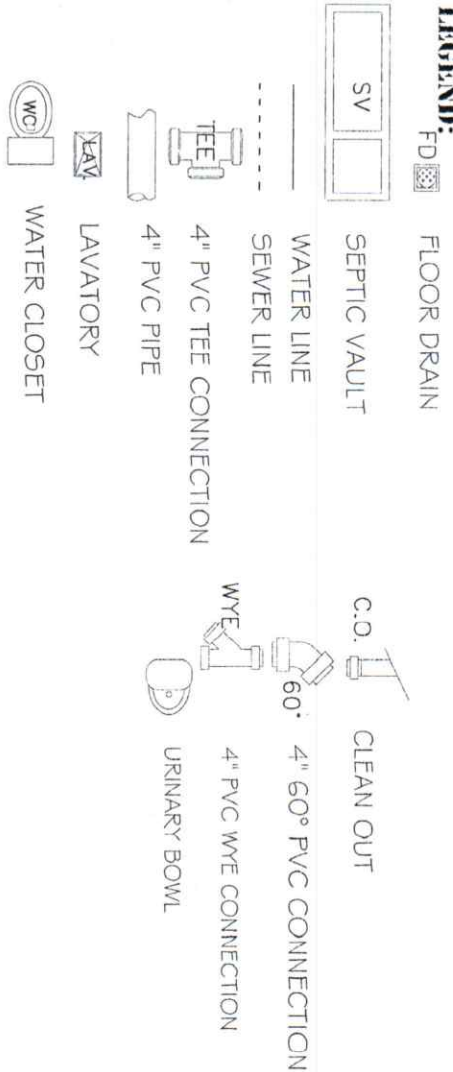


1 PLAN OF SEPTIC VAULT
P-2-P-2 SCALE
1:50


PREPARED BY: ROMBLON STATE UNIVERSITY OFFICE OF PHYSICAL PLANT AND FACILITIES	MASTER PLUMBER: JASON P. EURON	CHECKED BY: JASON P. EURON	PROJECT TITLE: REHABILITATION AND FURNISHING OF OLD/EXISTING UNIVERSITY BUILDING	SHEET CONTENT: HS SHOWN	PREPARED BY: CAD OPERATOR: BSSC / SIM JOB NO.:	
P/R No.: Date:	P/R No.: Date:	APPROVED BY: REHABILITATION MANAGER	LOCATION: ROMBLON STATE UNIVERSITY - Main Campus, Avarang, Dabangar, Romblon			

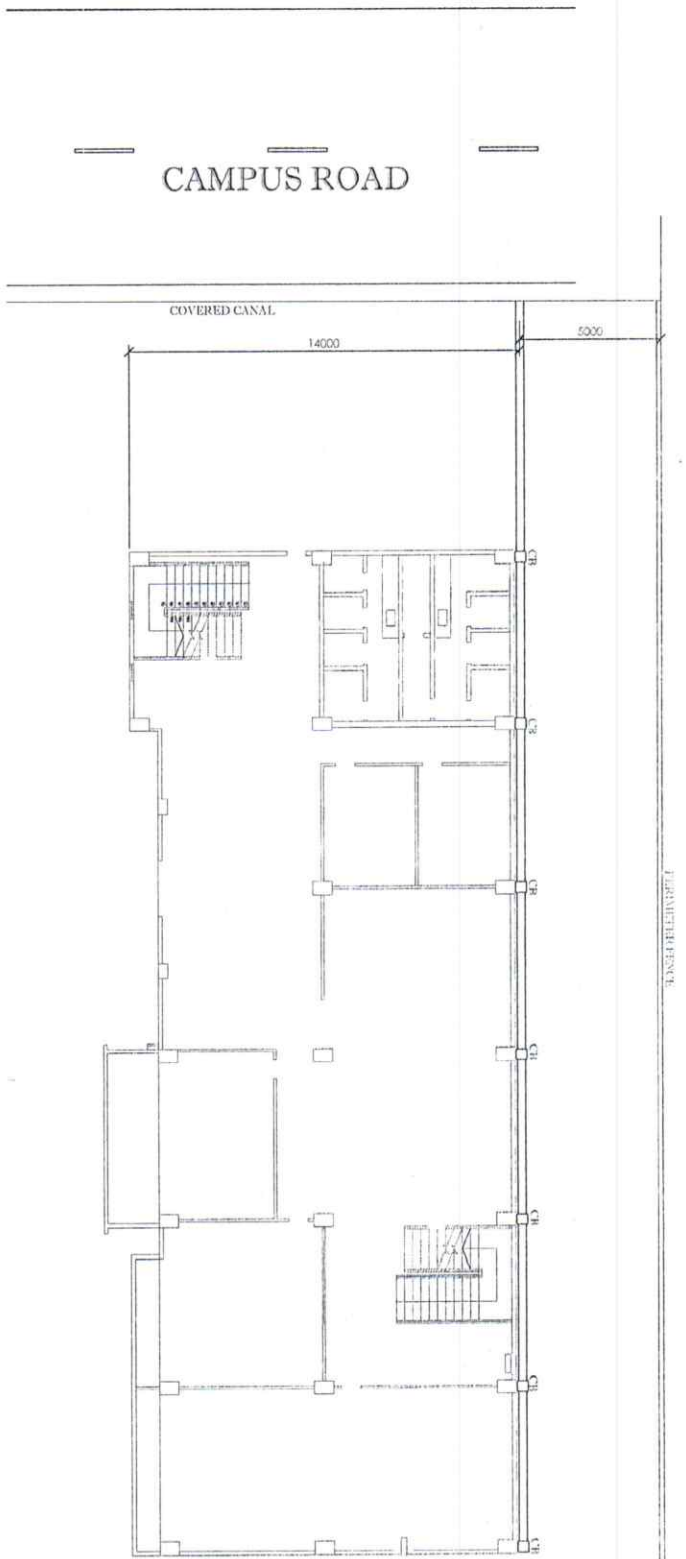

1 CATCH BASIN LAYOUT PLAN
 P-2 P-3 SCALE
 1:200

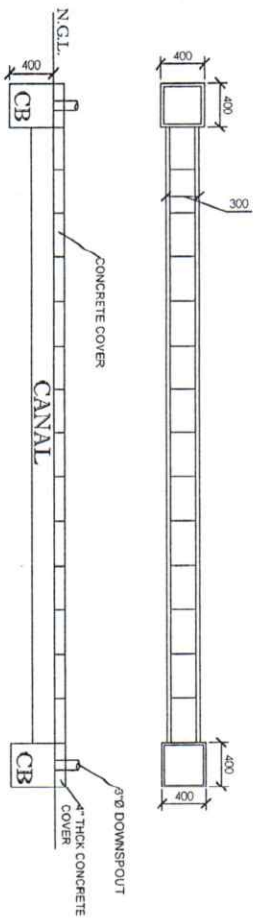


2 CATCH BASIN DETAIL
 P-2 P-3 SCALE
 NTS

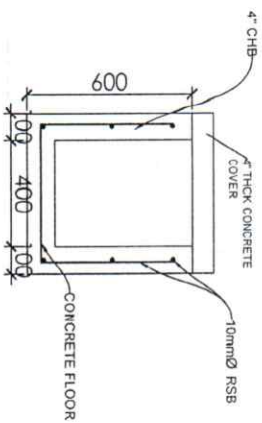

3 CANAL DETAILS
 P-2 P-3 SCALE
 NTS

PREPARED BY : ROMBLON STATE UNIVERSITY OFFICE OF PHYSICAL PLANT AND FACILITIES	MASTER PUNJER JERRY SIN / B. S. / F. S. PRC REG. NO. 1111111111 Date: 11/11/11 Place:	CHECKED BY : JASON P. RIFON MR. JASON P. RIFON RPT. No. 1111111111	PROJECT TITLE : REHABILITATION AND FURNISHING OF OLD/EXISTING UNIVERSITY BUILDING	SHEET CONTENT : IS SHOWN	PREPARED BY : CAD OPERATOR: BSCG / STM JOB NO. : DATE :	<div style="border: 1px solid black; border-radius: 50%; width: 40px; height: 40px; display: flex; align-items: center; justify-content: center; margin: 0 auto;"> P-3 </div>
LOCATION : ROMBLON STATE UNIVERSITY - Main Campus, Linao, Digos, Compostela						

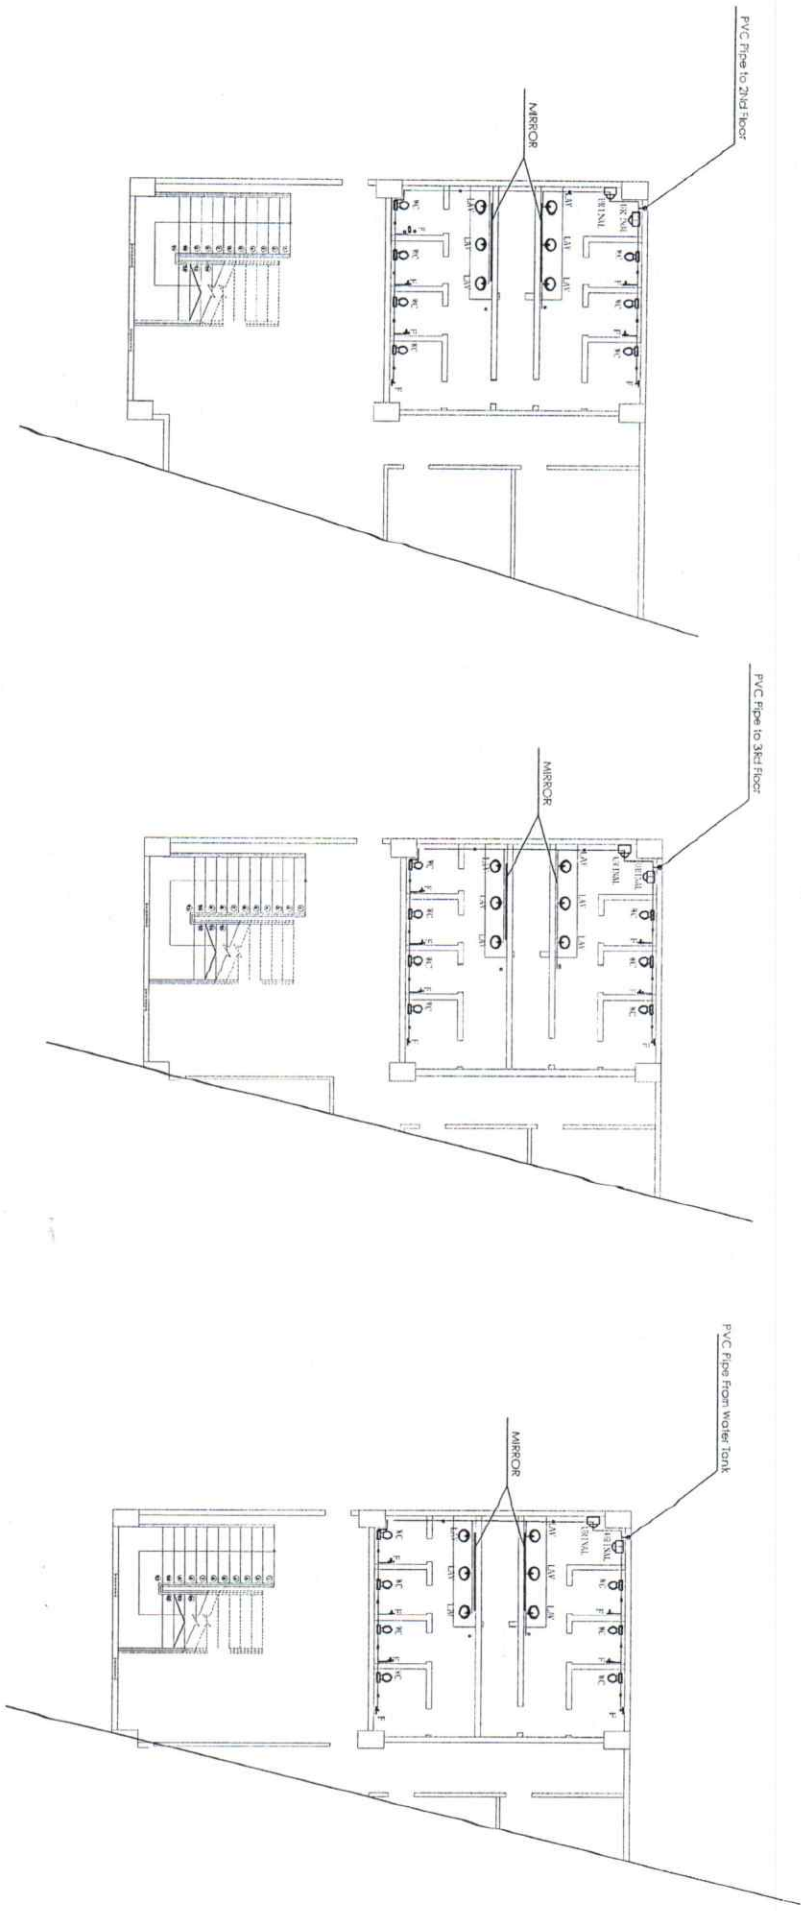


1 GROUND FLOOR WATER LAYOUT PLAN
 SCALE 1:150

2 SECOND FLOOR WATER LAYOUT PLAN
 SCALE 1:150

3 THIRD FLOOR WATER LAYOUT PLAN
 SCALE 1:150

PREPARED BY: ROBBLON STATE UNIVERSITY OFFICE OF PHYSICAL PLANT AND FACILITIES		MASTER NUMBER: CHECKED BY: LEON F. RUTSEN		PROJECT TITLE: REHABILITATION AND FURNISHING OF OLD/EXISTING UNIVERSITY BUILDING	
PROC REG. No.: PTR No.: Date: Place:		APPROVED BY: MERIAN P. ESTANISLAW ED. D. CLER SSI President		SHEET CONTENT: AS SHOWN	
DATE:		PREPARED BY: CAD OPERATOR		BCCG / SLM JOB NO.:	
P-4		DATE:		P-4	

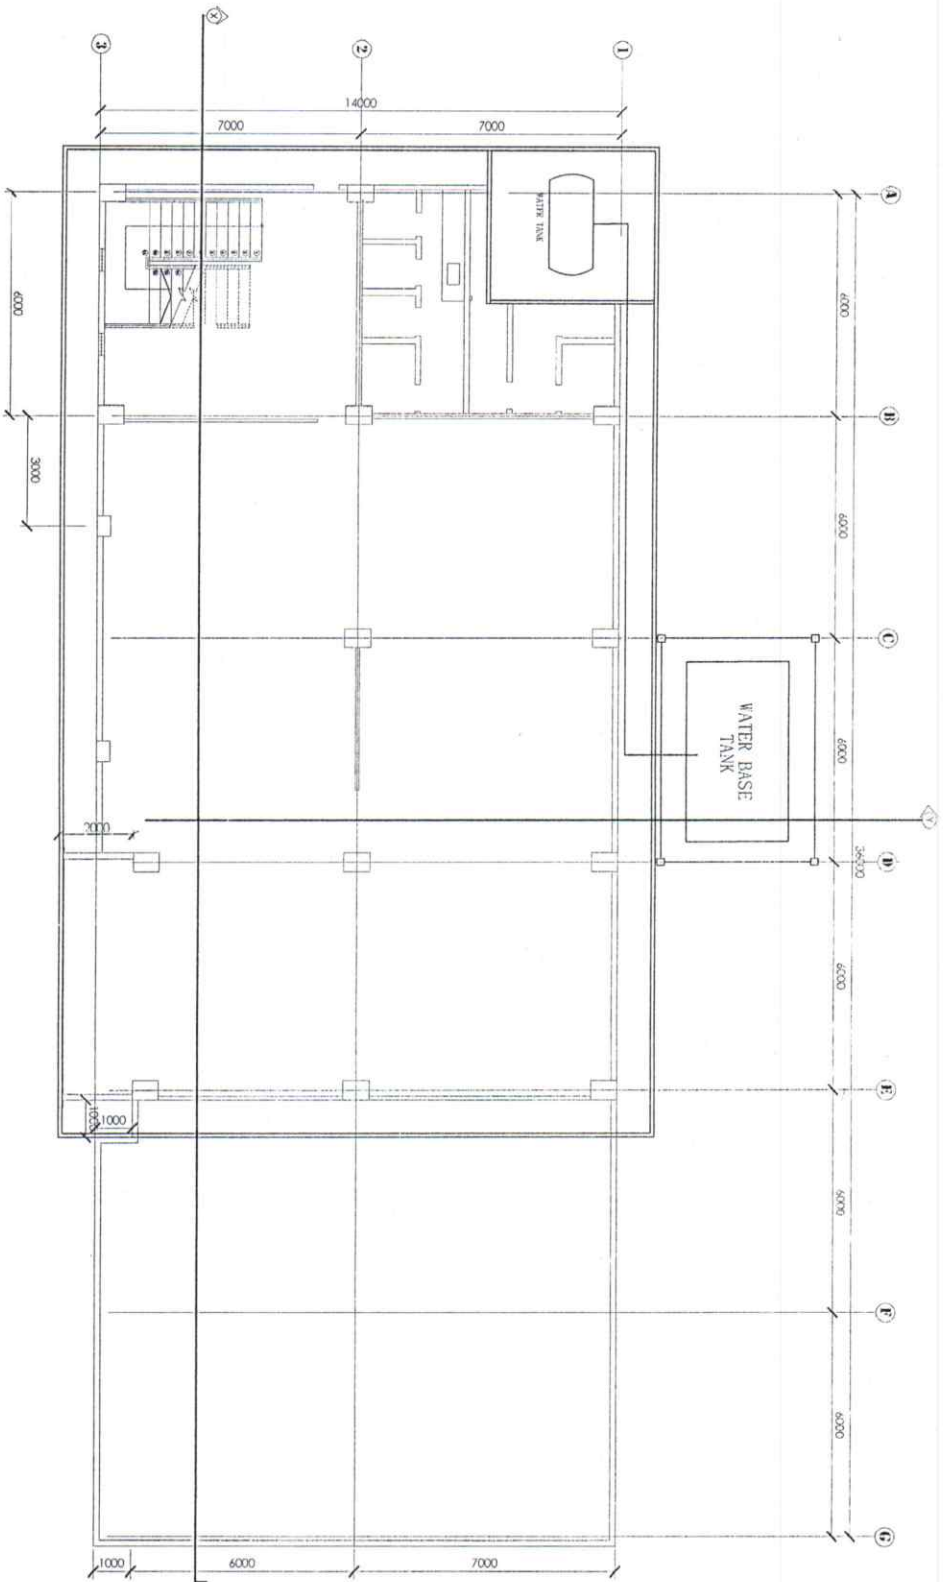

P-5
P-5


1 PLACEMENT OF WATER TANK

 SCALE 1:150


PREPARED BY : ROBBLON STATE UNIVERSITY OFFICE OF PHYSICAL PLANT AND FACILITIES	MASTER NUMBER CHECKED BY : JASON E. RICHON ASSISTANT VICE PRESIDENT FOR PHYSICAL PLANT AND FACILITIES	PROJECT TITLE : REHABILITATION AND FURNISHING OF OLD/EXISTING UNIVERSITY BUILDING LOCATION : ROBBLON STATE UNIVERSITY - Main Campus Library, Gangan, Romblon
PTF No. : Date : TIN :	PRC REG. No. : Date : TIN :	SHEET CONTENT : AS SHOWN
PREPARED BY : CAD OPERATOR : BSC / SM		PREPARED BY : JOB NO. : DATE :
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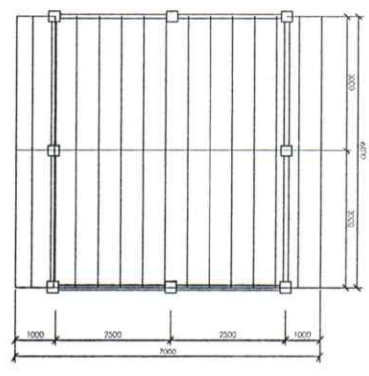
1 ELEVATION PLAN
 Scale: 1:100



3 FOUNDATION PLAN
 Scale: 1:100

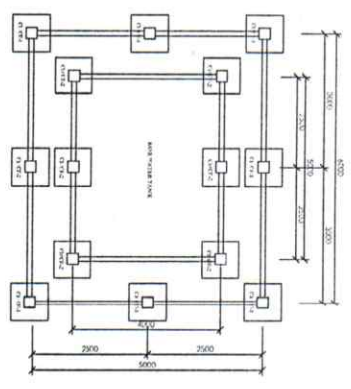


4 WATER BASE TANK SLAB PLAN
 Scale: 1:100

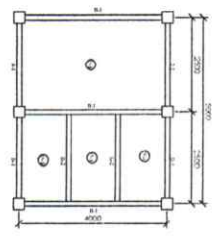


5 ROOF FRAMING PLAN (PUMP HOUSE)
 Scale: 1:100

2 GROUND FLOOR PLAN
 Scale: 1:100

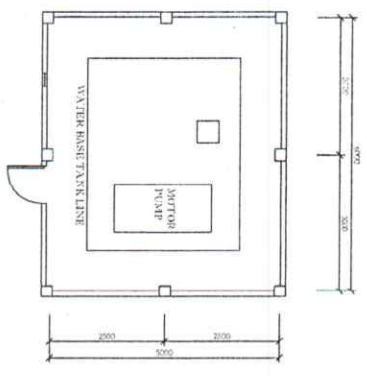


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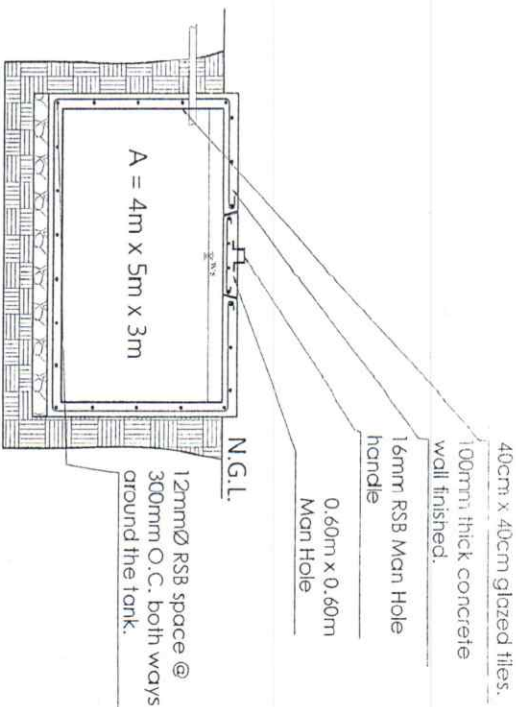
ROBINSON STATE UNIVERSITY
 OFFICE OF PHYSICAL PLANT AND FACILITIES
 JERRY S. GUN...
 JASON P. RITMAN
 MERIAN P. KATAYAVANANT ED. D. CRISH
 REHABILITATION AND FURNISHING OF
 OLD/EXISTING UNIVERSITY BUILDING
 LOCATION: ROBINSON STATE UNIVERSITY - Main Campus, Lembang, Bandung, Ranbar

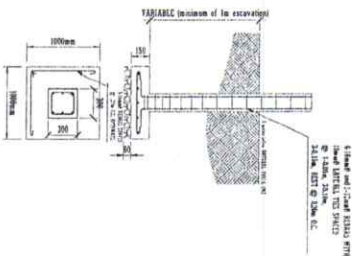


1 CI/CF1 & FOUNDATION PLAN
SCALE 1:50

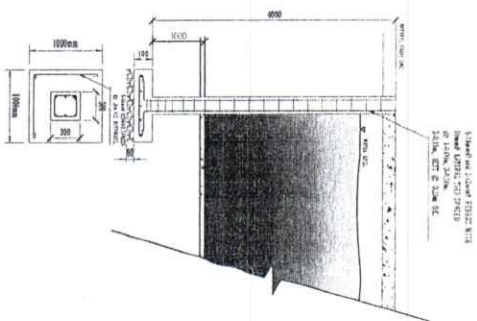

2 CI/CF2 & FOUNDATION PLAN
SCALE 1:30




3 WATER BASE TANK DETAILS
SCALE 1:25

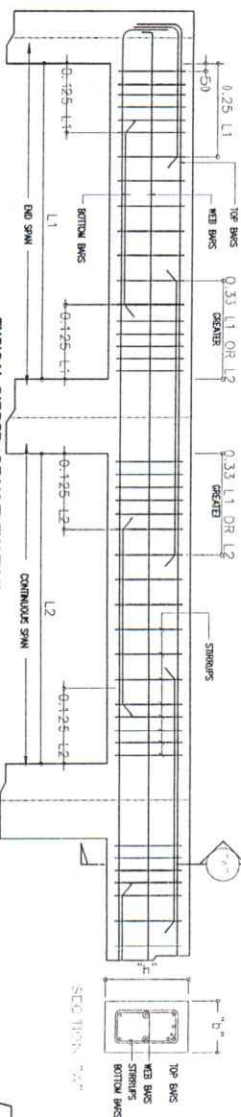

TYPICAL GIRDER/BEAM ELEVATION
SCALE 1:15

R.C. GIRDER/BEAM SCHEDULE		REINFORCEMENTS				STIRRUPS TYPES	
WORK	SIZE (mm)	LEFT SUPPORT		MID-Span		RIGHT SUPPORT	
		TOP	BOTTOM	TOP	BOTTOM	TOP	BOTTOM
B-1	250X350	3-#16	3-#16	3-#16	3-#16	#10	1050, 118/100, RES/0150
B-2	200X300	3-#16	3-#16	3-#16	3-#16	#10	1050, 118/100, RES/0150
RB	250X400	3-#16	3-#16	3-#16	3-#16	#10	1050, 118/100, RES/0150

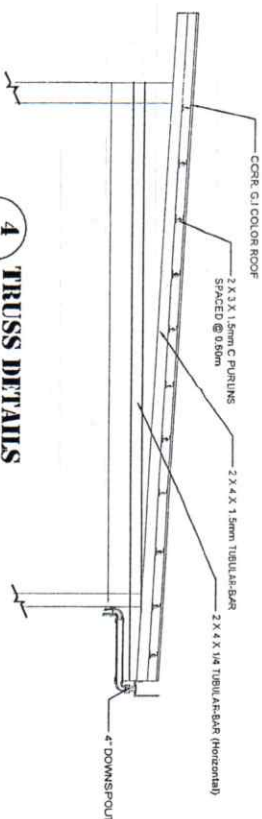

4 TRUSS DETAILS
SCALE 1:100

PREPARED BY: **ROMBION STATE UNIVERSITY**

OFFICE OF PHYSICAL PLANT AND FACILITIES

MASTER NUMBER: _____

CHECKED BY: _____

PROJECT TITLE: **REHABILITATION AND FURNISHING OF OLD/EXISTING UNIVERSITY BUILDING**

LOCATION: **ROMBION STATE UNIVERSITY - Main Campus, Living, Gopuram, Rombion**

SHEET CONTENT: **AS SHOWN**

PREPARED BY: _____

CAD OPERATOR: _____

BCSC / SLIM _____

JOB NO.: _____

DATE: _____

P-7